



I 3.1 AS-BUILT DRAWINGS


Please note that all drawings below are hyperlinked to the drawings listed in the below register. Please click on the drawing title to go directly to the drawing you wish to view.


Drawing Register: UMC Architects

FINISHES SCHEDULE


DRAWING NUMBER	DRAWING TITLE	REV
P23025-UMC-BR-XX-SC-A-1501	External Door Schedule	CR1
P23025-UMC-BR-XX-SC-A-1502	External Window Schedule	CR1
P23025-UMC-BR-XX-SC-A-1505	Internal Door Schedule	CR1
P23025-UMC-BR-ZZ-DR-A-1206	Office Finishes	CR1
P23025-UMC-BR-ZZ-DR-A-1208	Office Floor Finishes	CR1
P23025-UMC-BR-ZZ-DR-A-1209	Office Wall Finishes	CR1
P23025-UMC-EX-00-DR-A-0703	External Finishes	CR1



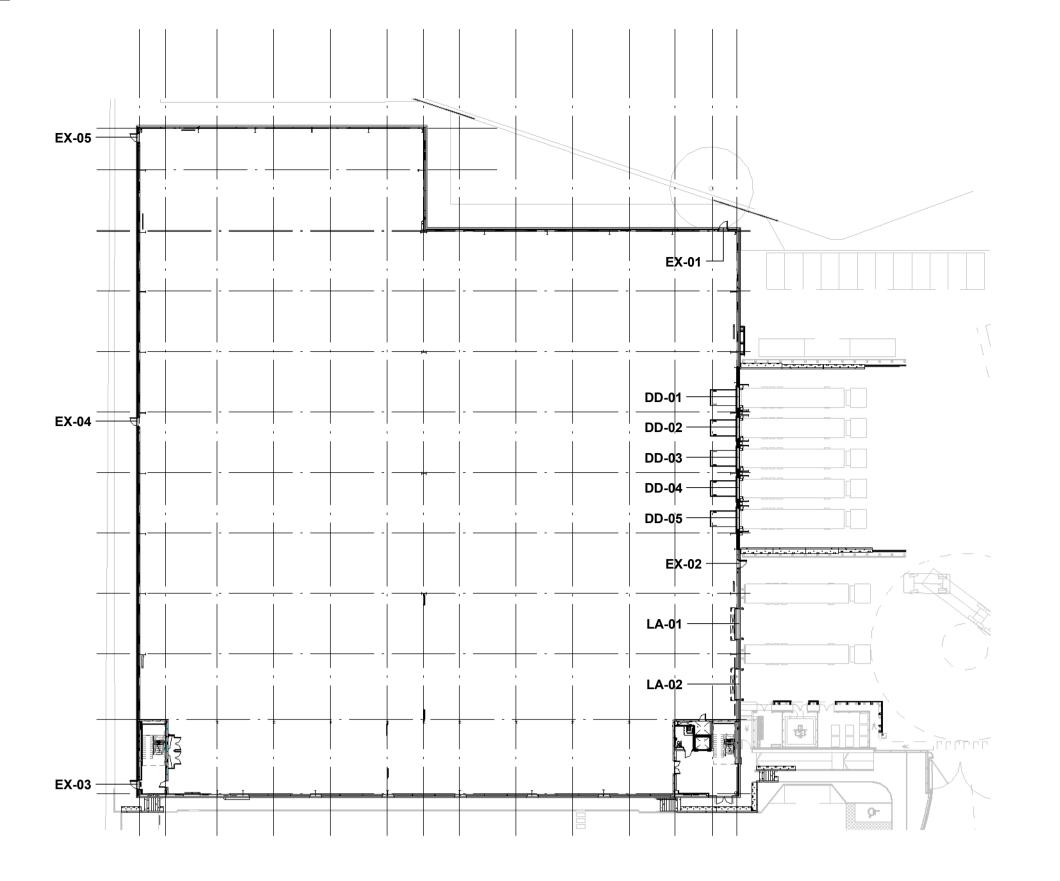

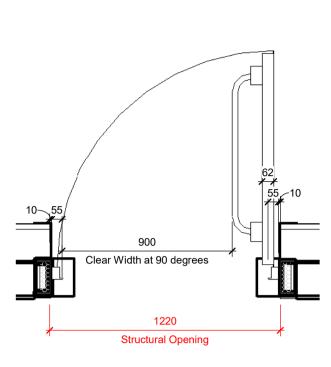

Typical External Door Plan
1:20

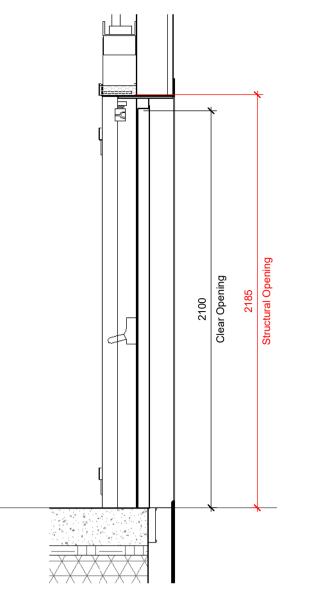

Typical Door Head Section

External Door Schedule Layout Key

1 · 500

									External Door Schedule						
					Constru	ction				Ironmonge	ery		Signage		
Mark	Manufacturer		Opening (mm) Width (90 degrees)		Opening (mm) Width	Fire Rating	U-Value	Colour	Handles	Latch	Hinges	Comment	Directional Arrow / Running Man	Fire Door Keep Shut (Both Sides Of Door).	
EX-01	Hormann	2100	900	2185	1220	None	1.6	RAL 9002 - Hamlet	Horman doors single point panic bar internally	Flush fittings to be in to panic hardware	Standard Hinge - 2no per leaf	Friction stays	Yes	Yes	
EX-02	Hormann	2100	900	2185	1220	None	1.6	RAL 7016 - Anthracite	Horman doors single point panic bar internally	Flush fittings to be in to panic hardware	Standard Hinge - 2no per leaf	Friction stays	Yes	Yes	
EX-03	Hormann	2100	900	2185	1220	None	1.6	RAL 9002 - Hamlet	Horman doors single point panic bar internally	Flush fittings to be in to panic hardware	Standard Hinge - 2no per leaf	Friction stays	Yes	Yes	
EX-04	Hormann	2100	900	2185	1220	None	1.6	RAL 7016 - Anthracite	Horman doors single point panic bar internally	Flush fittings to be in to panic hardware	Standard Hinge - 2no per leaf	Friction stays	Yes	Yes	
EX-05	Hormann	2100	900	2185	1220	None	1.6	RAL 9002 - Hamlet	Horman doors single point panic bar internally	Flush fittings to be in to panic hardware	Standard Hinge - 2no per leaf	Friction stays	Yes	Yes	

						Dock	Door Schedule	
		Clear O	pening (mm)					
Mark	Manufacturer	Height	Width	Vision Panel	U-Value	Fire Rating	Door Finish	Description
DD-01	Hormann	3000	3000	2No. acrylic double glazed vision panels wihtin 3rd door section	1.3	None	Finish: Polyester poweder coated Colour: Ext Silver (RAL 9006) Int: Off White (RAL 9002)	Hormann or similar SPU F42 WA300 electrically operated insulated sectional vertical lift door with low level springs complete with sliding bolts electrically interlocked and anit-fall devices
DD-02	Hormann	3000	3000	2No. acrylic double glazed vision panels wihtin 3rd door section	1.3	None	Finish: Polyester poweder coated Colour: Ext Silver (RAL 9006) Int: Off White (RAL 9002)	Hormann or similar SPU F42 WA300 electrically operated insulated sectional vertical lift door with low level springs complete with sliding bolts electrically interlocked and anit-fall devices
DD-03	Hormann	3000	3000	2No. acrylic double glazed vision panels wihtin 3rd door section	1.3	None	Finish: Polyester poweder coated Colour: Ext Silver (RAL 9006) Int: Off White (RAL 9002)	Hormann or similar SPU F42 WA300 electrically operated insulated sectional vertical lift door with low level springs complete with sliding bolts electrically interlocked and anit-fall devices
DD-04	Hormann	3000	3000	2No. acrylic double glazed vision panels wihtin 3rd door section	1.3	None	Finish: Polyester poweder coated Colour: Ext Silver (RAL 9006) Int: Off White (RAL 9002)	Hormann or similar SPU F42 WA300 electrically operated insulated sectional vertical lift door with low level springs complete with sliding bolts electrically interlocked and anit-fall devices
DD-05	Hormann	3000	3000	2No. acrylic double glazed vision panels wihtin 3rd door section	1.3	None	Finish: Polyester poweder coated Colour: Ext Silver (RAL 9006) Int: Off White (RAL 9002)	Hormann or similar SPU F42 WA300 electrically operated insulated sectional vertical lift door with low level springs complete with sliding bolts electrically interlocked and anit-fall devices

									Level Access Do	or Shedule			
		Clear Opening (mm)			Opening (mm)	Inst	Insulation Tolerance (mm)				Fire Rating		
Mark	Manufacturer	Height	Width	Height	Width	Head	Jamb LHS	Jamb RHS	Vision Panel	U-Value	Text	Finish	Description
LA-01	Hormann	4800	4000	4875	4140	70	70	70	3no Rectangular Panels, in 3rd panel up	1.1	None	Finish: Polyester poweder coated Colour: Ext Silver (RAL 9006) Int: Off White (RAL 9002)	Hormann or similar SPU F42 A445 electrically operated insulated sectional overhead door with manual override. Standard lift doors with low level springs complete with sliding bolts electrically interlocked and anti-fall devices.
LA-02	Hormann	4800	4000	4875	4140	70	70	70	3no Rectangular Panels, in 3rd panel up	1.1	None	Finish: Polyester poweder coated Colour: Ext Silver (RAL 9006) Int: Off White (RAL 9002)	Hormann or similar SPU F42 A445 electrically operated insulated sectional overhead door with manual override. Standard lift doors with low level springs complete with sliding bolts electrically interlocked and anti-fall devices.

- Dimensions are all in millimeters, unless stated otherwise.
- It is the recipients responsibility to print this document to the correct scale.
- All the relevant drawings and specifications should be read in conjunction with this drawing.
- Scaling of this drawing is not recommended.

NOTE:

For full door details refer to the Hormann drawings:

Dock leveller doors P23025-HOR-ZZ-00-DR-X-0001

Level access doors P23025-HOR-ZZ-00-DR-X-0002

Single Leaf Doorset P23025-HOR-ZZ-00-DR-X-0003

FOR DOOR DETAILS REFER TO HORMANN DOORS LATEST CONSTRUCTION RECORD/ AS-BUILT DRAWINGS

C02 Amended to reflect Hormann comments recieved 23.02.24.

C01 External door insulation to be inside of PFC. Clear height of 2100mm and clear width of 900mm at 90 degrees as agreed with Hormann, structural openings have been added to schedule. Door references added and door details included for. Clear opening updated to align to Hormann on dock door schedule and insulation tolerance removed. On the level access door schedule the structural opening has been added to include for insulation tolerances.

P01 Preliminary Issue SW LK 24.11.23

rev amendments by LK 24.11.23


LK SW 27.08.24

Horton Road, Poyle

External Door Schedule

CR1 Construction Record Issue



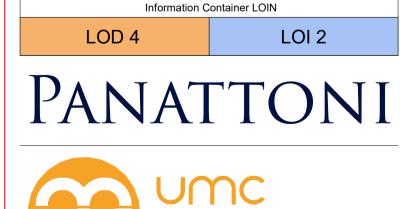

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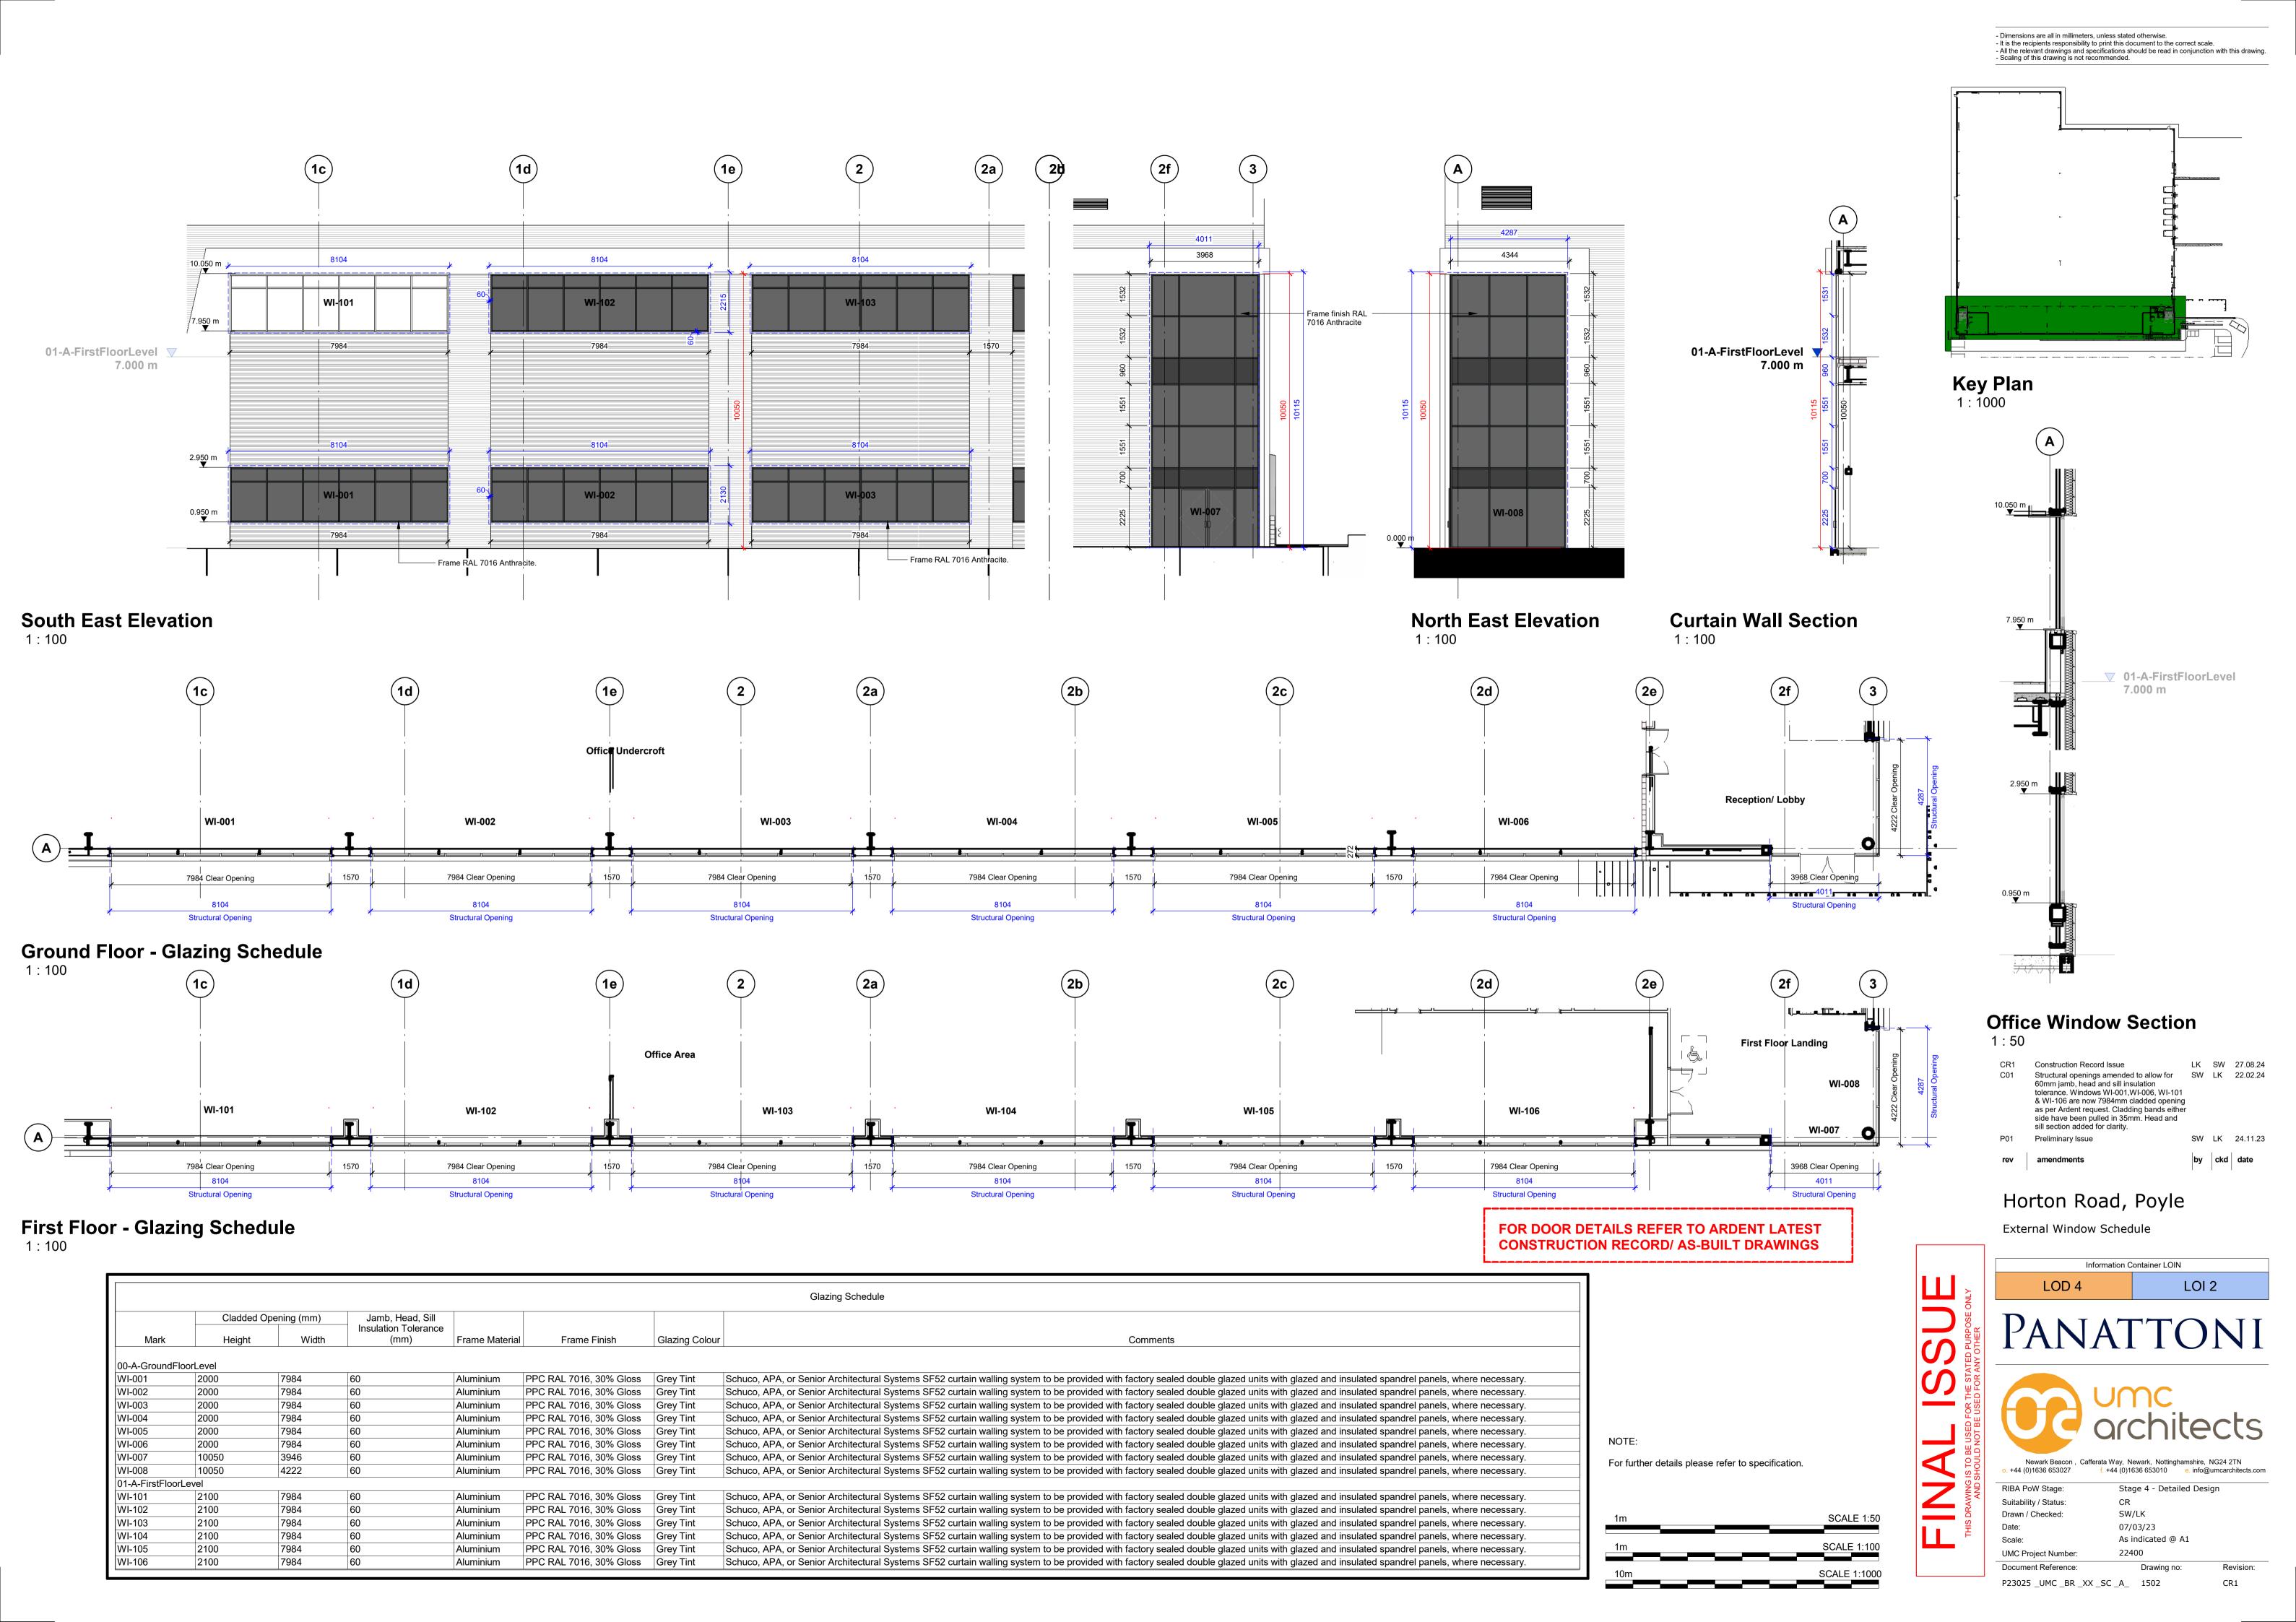
Newark Beacon , Carlerata Way, Newark, Nottingnamshire, NG24 21N
o. +44 (0)1636 653027 f. +44 (0)1636 653010 e. info@umcarchitects.com


RIBA PoW Stage: Stage 4 - Detailed Design
Suitability / Status: CR
Drawn / Checked: SW/LK


Date: 07/03/23
Scale: As indicated @ A1
UMC Project Number: 22400

Document Reference: Drawing no:
P23025 _UMC _BR _XX _SC _A_ 1501


CR1




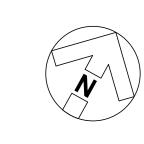

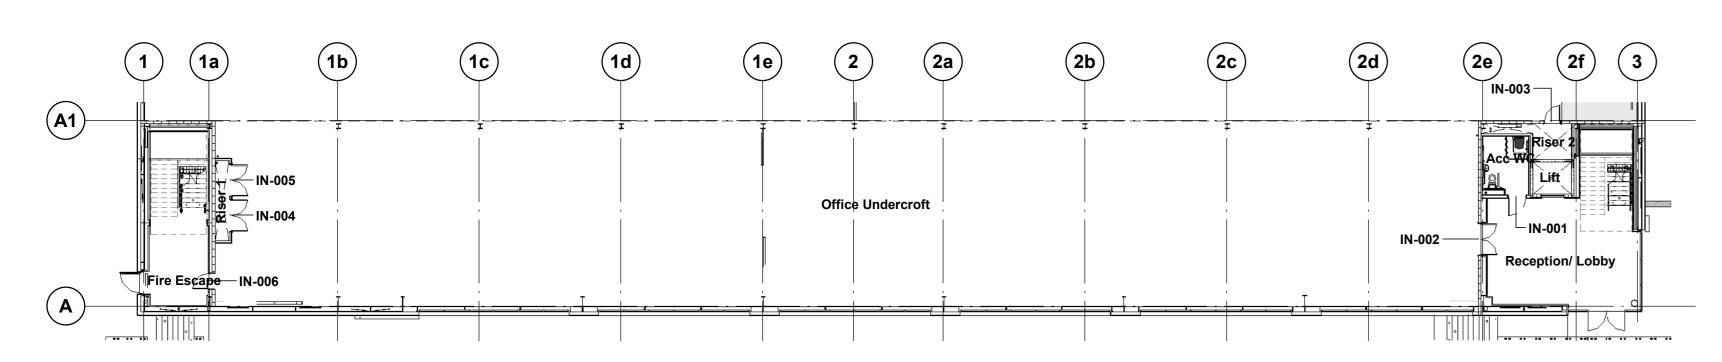

Ground Floor Office Plan

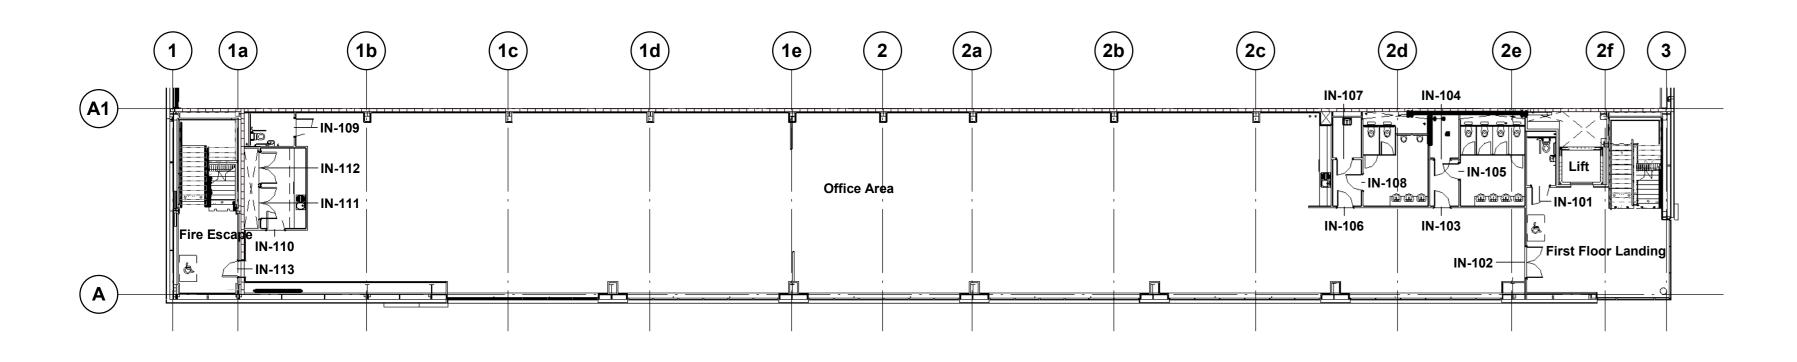


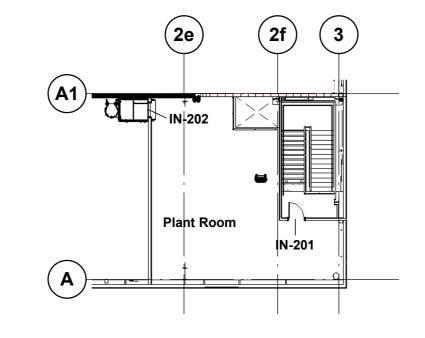


First Floor Office Plan

Plant Deck Plan
1:200


	ı																			
		Frame	Frame Opening		Construction			Ironmongery			Disabled	Fomolo	Mala	Signa Unise		Directional Arrow /	Eiro Door Koon	Fire Door Keep SI		
Mark Do	or Type Ope		Height	Fire Rating	Finish	Vision Panel	Handles	Lock / Latch	Closer	Kick Plate	Hinges	Door Stop	Disabled pictogram	Female W.C.	Male W.C.	W.C.	Shower	Running Man	Locked	(Both Sides Of Doo
		-						,						•						-
-A-GroundFloor -001 6	oorLevel 1010	0 3	100	n/a	Timber veneered, non-tropical American	None	Lift to lock handle with external	None	None	250mm tall S/S Kickplate to	o 1 1/2 pairs heavy duty, Grade 316	Rubber buffer door stops -Rubber	Voc	No	No	No	No	No	No	No
N-001 0	1010	0 2	100	II/a	Light Oak or equal approved	None	indicator	None	None	both sides of door	stainless steel butt hinges	stop inside aluminium holder	162	INO	INO	INO	INO	INO	INO	INO
N-002 4	1735	5 2	100	60 Mintues	Timber veneered, non-tropical American	150 x 750mm vision panel to	Grade 316 stainless steel tubular	None	Grade 316 stainless steel	150mm tall S/S Kickplate to	o 3no. pairs heavy duty Grade 316	Rubber buffer door stops -Rubber	No	No	No	No	No	Yes	No	Yes
					Light Oak or equal approved	main leaf only. Glazing to be fire rated to achieve requirements	stainless steel push plate		Heavy-duty overhead closer		stainless steel butt hinges	stop inside aluminium holder								
1-003 3	910		100	60 Mintues	Timber veneered, non-tropical American Light Oak or equal approved	None	Grade 316 stainless steel tubular pull handle with Grade 316 stainless steel push plate	internal thumb-turn override	Grade 316 stainless steel Heavy-duty overhead closer		stainless steel butt hinges	stop inside aluminium holder		No	No	No	No	No	Yes	No
1-004 5	1735	5 2	100	30 Minutes	Timber veneered, non-tropical American Light Oak or equal approved	None	Grade 316 stainless steel tubular pull handle with Grade 316 stainless steel push plate	Mortice lock with internal thumb-turn override	Grade 316 stainless steel Heavy-duty overhead closer		o 3no. pairs heavy duty Grade 316 stainless steel butt hinges	Rubber buffer door stops -Rubber stop inside aluminium holder	No	No	No	No	No	No	Yes	No
N-005 5	1735	5 2	100	30 Minutes	Timber veneered, non-tropical American Light Oak or equal approved	None	Grade 316 stainless steel tubular pull handle with Grade 316 stainless steel push plate	Mortice lock with internal thumb-turn override	Grade 316 stainless steel Heavy-duty overhead closer		o 3no. pairs heavy duty Grade 316 stainless steel butt hinges	Rubber buffer door stops -Rubber stop inside aluminium holder	No	No	No	No	No	No	Yes	No
N-006 2	910	2	100	60 Mintues	Timber veneered, non-tropical American Light Oak or equal approved	150 x 750mm vision panel to main leaf only. Glazing to be fire rated to achieve requirements		None	Grade 316 stainless steel Heavy-duty overhead closer		o 1 1/2 pairs heavy duty, Grade 316 stainless steel butt hinges	Rubber buffer door stops -Rubber stop inside aluminium holder	No	No	No	No	No	Yes	No	Yes
N-203	910	2	170				1 1 222				1 1/2 pairs heavy duty, Grade 316	3								
1-A-FirstFloor	Lovel										stainless steel butt hinges									
N-101 6	Level 1010	0 2	100	n/a	Timber veneered, non-tropical American Light Oak or equal approved	None	Lift to lock handle with external indicator	None	None	250mm tall S/S Kickplate to	o 1 1/2 pairs heavy duty, Grade 316 stainless steel butt hinges	Rubber buffer door stops -Rubber stop inside aluminium holder	Yes	No	No	No	No	No	No	No
N-102 4	1735	5 2	100	60 Mintues	Timber veneered, non-tropical American Light Oak or equal approved	150 x 750mm vision panel to main leaf only. Glazing to be fire rated to achieve requirements	Grade 316 stainless steel tubular pull handle with Grade 316 stainless steel push plate	None	Grade 316 stainless steel Heavy-duty overhead closer		o 3no. pairs heavy duty Grade 316 stainless steel butt hinges	Rubber buffer door stops -Rubber stop inside aluminium holder	No	No	No	No	No	Yes	No	Yes
N-103 1	910	2	100	n/a	Timber veneered, non-tropical American Light Oak or equal approved	None	Grade 316 stainless steel tubular pull handle with Grade 316 stainless steel push plate	None	Grade 316 stainless steel Heavy-duty overhead closer	150mm tall S/S Kickplate to both sides of door	o 1 1/2 pairs heavy duty, Grade 316 stainless steel butt hinges	Rubber buffer door stops -Rubber stop inside aluminium holder	No	Yes	No	No	No	No	No	No
N-104 3	910	2	100	n/a	Timber veneered, non-tropical American Light Oak or equal approved	None	Grade 316 stainless steel tubular pull handle with Grade 316	Mortice lock with internal thumb-turn	Grade 316 stainless steel Heavy-duty overhead closer		o 1 1/2 pairs heavy duty, Grade 316 stainless steel butt hinges	Rubber buffer door stops -Rubber stop inside aluminium holder	No	No	No	No	No	No	Yes	No
N-105 1	910		100		Timb and an Americal American	Nama	stainless steel push plate	override	Grade 316 stainless steel	450	- 4.4/0 in- h	Dubban buffan daan dan Dubban	NI-	No	No	No	NI-	No	NI-	NI
N-105 I	910	2	100	n/a	Timber veneered, non-tropical American Light Oak or equal approved	None	Grade 316 stainless steel tubular pull handle with Grade 316 stainless steel push plate	None	Heavy-duty overhead closer		o 1 1/2 pairs heavy duty, Grade 316 stainless steel butt hinges	Rubber buffer door stops -Rubber stop inside aluminium holder	INO	INO	INO	INO	NO	NO	NO	INO
N-106 1	910	2	100	n/a	Timber veneered, non-tropical American Light Oak or equal approved	None	Grade 316 stainless steel tubular pull handle with Grade 316 stainless steel push plate	None	Grade 316 stainless steel Heavy-duty overhead closer		o 1 1/2 pairs heavy duty, Grade 316 stainless steel butt hinges	Rubber buffer door stops -Rubber stop inside aluminium holder	No	No	Yes	No	No	No	No	No
N-107 3	910	2	100	30 Minutes	Timber veneered, non-tropical American Light Oak or equal approved	None	Grade 316 stainless steel tubular pull handle with Grade 316 stainless steel push plate	Mortice lock with internal thumb-turn override	Grade 316 stainless steel Heavy-duty overhead closer		o 1 1/2 pairs heavy duty, Grade 316 stainless steel butt hinges	Rubber buffer door stops -Rubber stop inside aluminium holder	No	No	No	No	No	No	Yes	No
N-108 1	910	2	100	n/a	Timber veneered, non-tropical American Light Oak or equal approved	None	Grade 316 stainless steel tubular pull handle with Grade 316 stainless steel push plate	None	Grade 316 stainless steel Heavy-duty overhead closer		o 1 1/2 pairs heavy duty, Grade 316 stainless steel butt hinges	Rubber buffer door stops -Rubber stop inside aluminium holder	No	No	No	No	No	No	No	No
N-109 6	1010	0 2	100	n/a	Timber veneered, non-tropical American Light Oak or equal approved	None	Lift to lock handle with external indicator	None	None	250mm tall S/S Kickplate to both sides of door	o 1 1/2 pairs heavy duty, Grade 316 stainless steel butt hinges	Rubber buffer door stops -Rubber stop inside aluminium holder	Yes	No	No	No	No	No	No	No
N-110 7	1010	0 2	100	n/a	Timber veneered, non-tropical American Light Oak or equal approved	main leaf only. Glazing to be fire		None	Grade 316 stainless steel Heavy-duty overhead closer		o 1 1/2 pairs heavy duty, Grade 316 stainless steel butt hinges	Rubber buffer door stops -Rubber stop inside aluminium holder	No	No	No	No	No	No	No	No
N-111 5	1735	5 2	100	30 Minutes	Timber veneered, non-tropical American Light Oak or equal approved	None	Grade 316 stainless steel tubular pull handle with Grade 316 stainless steel push plate	Mortice lock with internal thumb-turn override	Grade 316 stainless steel Heavy-duty overhead closer	150mm tall S/S Kickplate to both sides of door	o 3no. pairs heavy duty Grade 316 stainless steel butt hinges	Rubber buffer door stops -Rubber stop inside aluminium holder	No	No	No	No	No	No	Yes	No
N-112 5	1735	5 2	100	30 Minutes	Timber veneered, non-tropical American Light Oak or equal approved	None	Grade 316 stainless steel tubular pull handle with Grade 316 stainless steel push plate		Grade 316 stainless steel Heavy-duty overhead closer		o 3no. pairs heavy duty Grade 316 stainless steel butt hinges	Rubber buffer door stops -Rubber stop inside aluminium holder	No	No	No	No	No	No	Yes	No
I-113 2	910	2	100	60 Mintues	Timber veneered, non-tropical American Light Oak or equal approved	150 x 750mm vision panel to main leaf only. Glazing to be fire rated to achieve requirements	Grade 316 stainless steel tubular		Grade 316 stainless steel Heavy-duty overhead closer		o 1 1/2 pairs heavy duty, Grade 316 stainless steel butt hinges	Rubber buffer door stops -Rubber stop inside aluminium holder	No	No	No	No	No	Yes	No	Yes
-A-Plant Dec																				
V-201 2	910	2	100	30 Minutes	Timber veneered, non-tropical American Light Oak or equal approved	150 x 750mm vision panel to main leaf only. Glazing to be fire rated to achieve requirements		Mortice lock with internal thumb-turn override	Grade 316 stainless steel Heavy-duty overhead closer		o 1 1/2 pairs heavy duty, Grade 316 stainless steel butt hinges	Rubber buffer door stops -Rubber stop inside aluminium holder	No	No	No	No	No	Yes	No	Yes
N-202 2	810	2	100	60 Mintues	Timber veneered, non-tropical American Light Oak or equal approved	None	Grade 316 stainless steel tubular pull handle with Grade 316 stainless steel push plate	Mortice lock with internal thumb-turn override	Grade 316 stainless steel Heavy-duty overhead closer		o 1 1/2 pairs heavy duty, Grade 316 stainless steel butt hinges	Rubber buffer door stops -Rubber stop inside aluminium holder	No	No	No	No	No	Yes	No	Yes

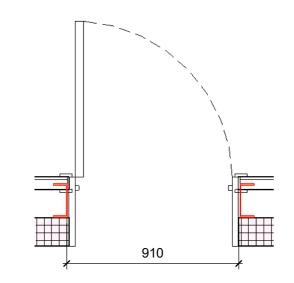


Typical Single Door Plan

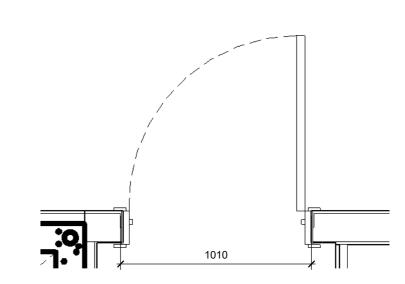



Typical Single Acc. Door Plan

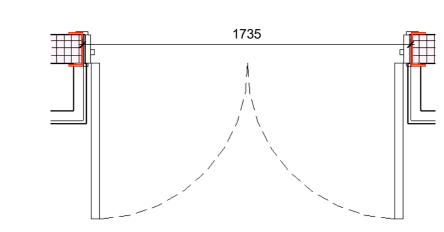



Typical Double Door Plan
1:20

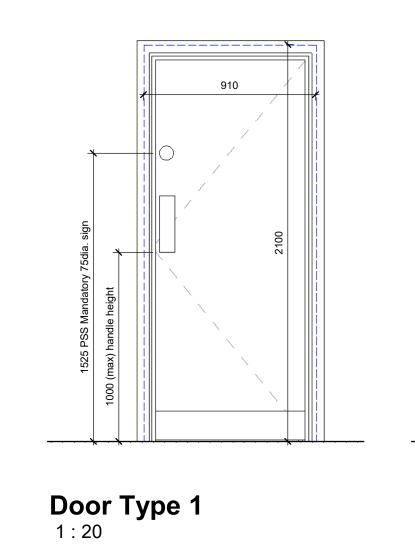


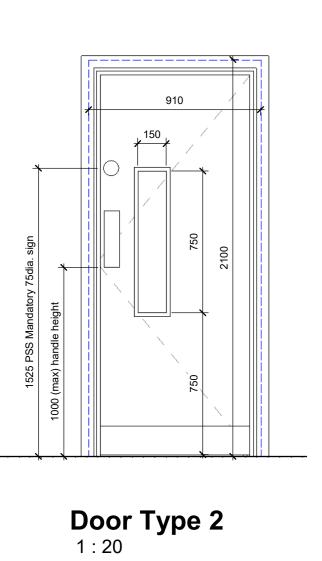


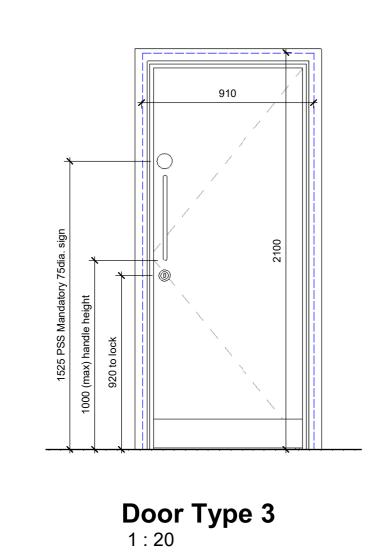

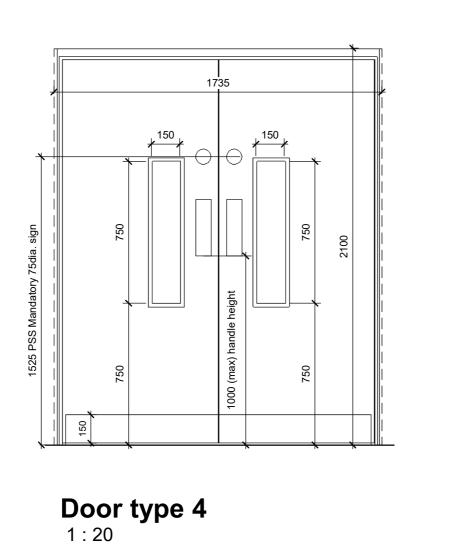

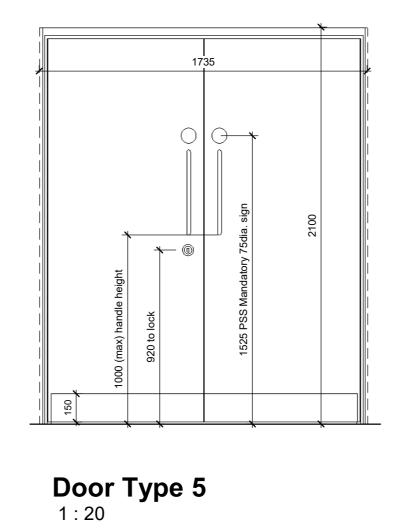

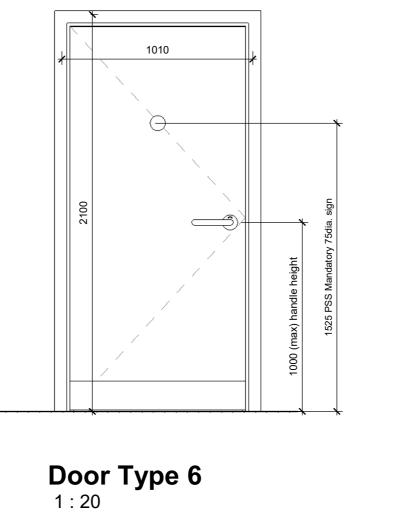

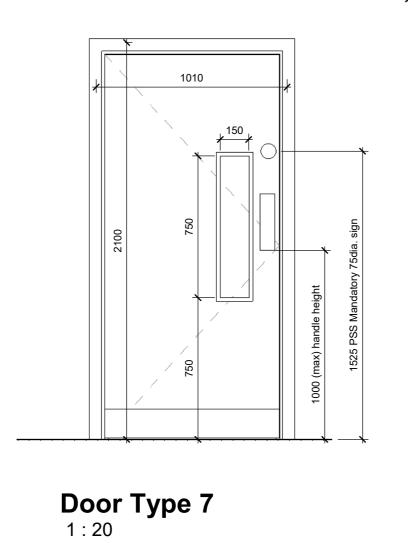

THIS DRAWING IS TO BE USED FOR THE STATED PURPOSE ONLY AND SHOULD NOT BE USED FOR ANY OTHER



CR1 Construction Record Issue

to drawing.

been amended

C07 All internal doors to be timber veneered, SW LK 02.07.24 non-tropical American Light Oak as per the

C06 Fire rating of door openings within the wall SW LK 26.06.24 align to building regulations as per the specification and as confirmed by Winvic 05.06.24.

C05 Door heights and widths altered in line with SW LK 18.06.24 door manufacturer.

C04 Door type references and elevations added SW LK 17.06.24

C03 Fire strategy updated in line with comments LK SW 05.06.24

whitewall still in abeyance awaiting comments

C02 Following confirmation of the whitewall fire LK SW 15.04.24 rating as 120min, the relevant doors have

from G&A and Winvic, internal doors to

LK SW 27.08.24

100mm SCALE 1:20

1m SCALE 1:200

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RIBA PoW Stage: Stage 4 - Detailed Design
Document Suitability: CR
Drawn / Checked: SW/LK
Date: 13/03/23
Scale: As indicated @ A0
UMC Project Number: 22400

Document Reference: Drawing no: Revise

P23025_UMC _BR _XX _SC _A_ 1505

Plasterd/ dry lined and fully sealed. Painted with one mist coat and two coats Dulux Trade Diamond Matt emulsion paint BS4800 22B15

Main Wall Tiles: 600mmx300mm Johnson Tiles Minerals Range MIN02N Dolomite Natural,

600mmx300mm Johnson Tiles IMP05P Charcoal polished ceramic tiles laid/fixed landscape format. Mechanical safety/retaining fixing system (RAIFIX or equal and approved) to be employed for all feature wall tiling 3.0m or more AFFL. Feature tiled wall to be 'framed' between walls or between projecting 'nibs' constructed for this purpose. Feature tiled wall to be kept clear of any fixtures/fitting of any

Feature Wall Tiles: 600mmx300mm Johnson

Tiles Minerals Range MIN05N Slate Natural,

Splashback 200mmx100mmx6.5mm Johnsons Tiles "Prismatics" PRG1 White Gloss laid horizontally (landscape), with proprietary white gloss or brushed stainless steel trims to all

Ceramic tiled splashback above all worktops

Full height IPS to WCs, Urinals and vanity units. Refer to sepcification for further details.

taken up to underside of wall cupboards.

Power floated concrete or screed finish.

600mmx600mmx11mm ceramic floor tiles Johnson Tiles Minerals Range MIN03G

600mmx600mm Johnson Tiles Minerals Range

200mmx200mmx8.3mm ceramic floor tiles Johnson Tiles Kerastar KER558 'Clay Speckle'

Interface Transformation 'Fern' 1628010 carpet

600x600mm wide Armstrong Dune eVo Tegular

enamelled finish on wire hangers. (3100mm

600x600mm wide Armstrong Dune eVo or similar moisture resistant tiles in lay-in grid

Dulux Absolute White vinyl matt emulsion

Minimum 600mm(W) x 100mm(D) Dulux Abolute White vinyl matt emulsion painted

Dulux Abolute White vinyl matt emulsion

painted plasterboard/ MF flat bulkhead to

100mm Firemaster Panel fixed to the u/s of

Plasterboarded with taped joints, sealed with one mist coat and two coats of Dulux Absolute

600mmx50mmx9mm ceramic tiles Johnson Tiles Minerals Range MIN05N 'Slate Natural'

200mmx100mmx8.3 Johnson Tiles Kerastar

600mmx100mm Johnson Tiles Minerals Range

Ex 100mmx25mm hardwood to match the door veneer, splayed skirting for clear finishing.

LK SW 27.08.24

SW LK 08.12.23 SW LK 24.11.23

by ckd date

plasterboard/ MF flat bulkhead.

White vinyl matt emulsion.

KER558 Clay Speckle Natural.

MIN05N Slate Natural.

For further detail on finishes see individual finishes drawings.

P23025_UMC_BR_ZZ_DR_A_1201 Office Ceiling Plans

P23025_UMC_BR_ZZ_DR_A_1208 Office Floor Finishes

P23025_UMC_BR_ZZ_DR_A_1209 Office Wall Finishes

C02 Drawing revised to include CAT ladder as LK SW 23.07.24

C01 Offices finishes schedule amended to align SW LK 05.03.24

per Winvic email 22/07/24, carpet finishes updated to stairs and main office to be Fern

as agreed with Panattoni, splash back

included to cleaners store

with individual finishes drawings Issued for review and comment

Horton Road, Poyle

CR1 Construction Record Issue

Office Finishes

No ceiling

C06

NOTE:

painted moisture-resistant plasterboard ceiling above WC cubicles and wash basins.

tiles in lay-in grid system with a stove

To be supplied by CFS, Stockdale range

'Limestone Grip'

MIN05G Slate Grip;

Colour: Chacoal - 3923

system. (3100mm high).

'Swansdown'.


laid/fixed landscape format;

laid/fixed landscape format;

Key

FINISHES



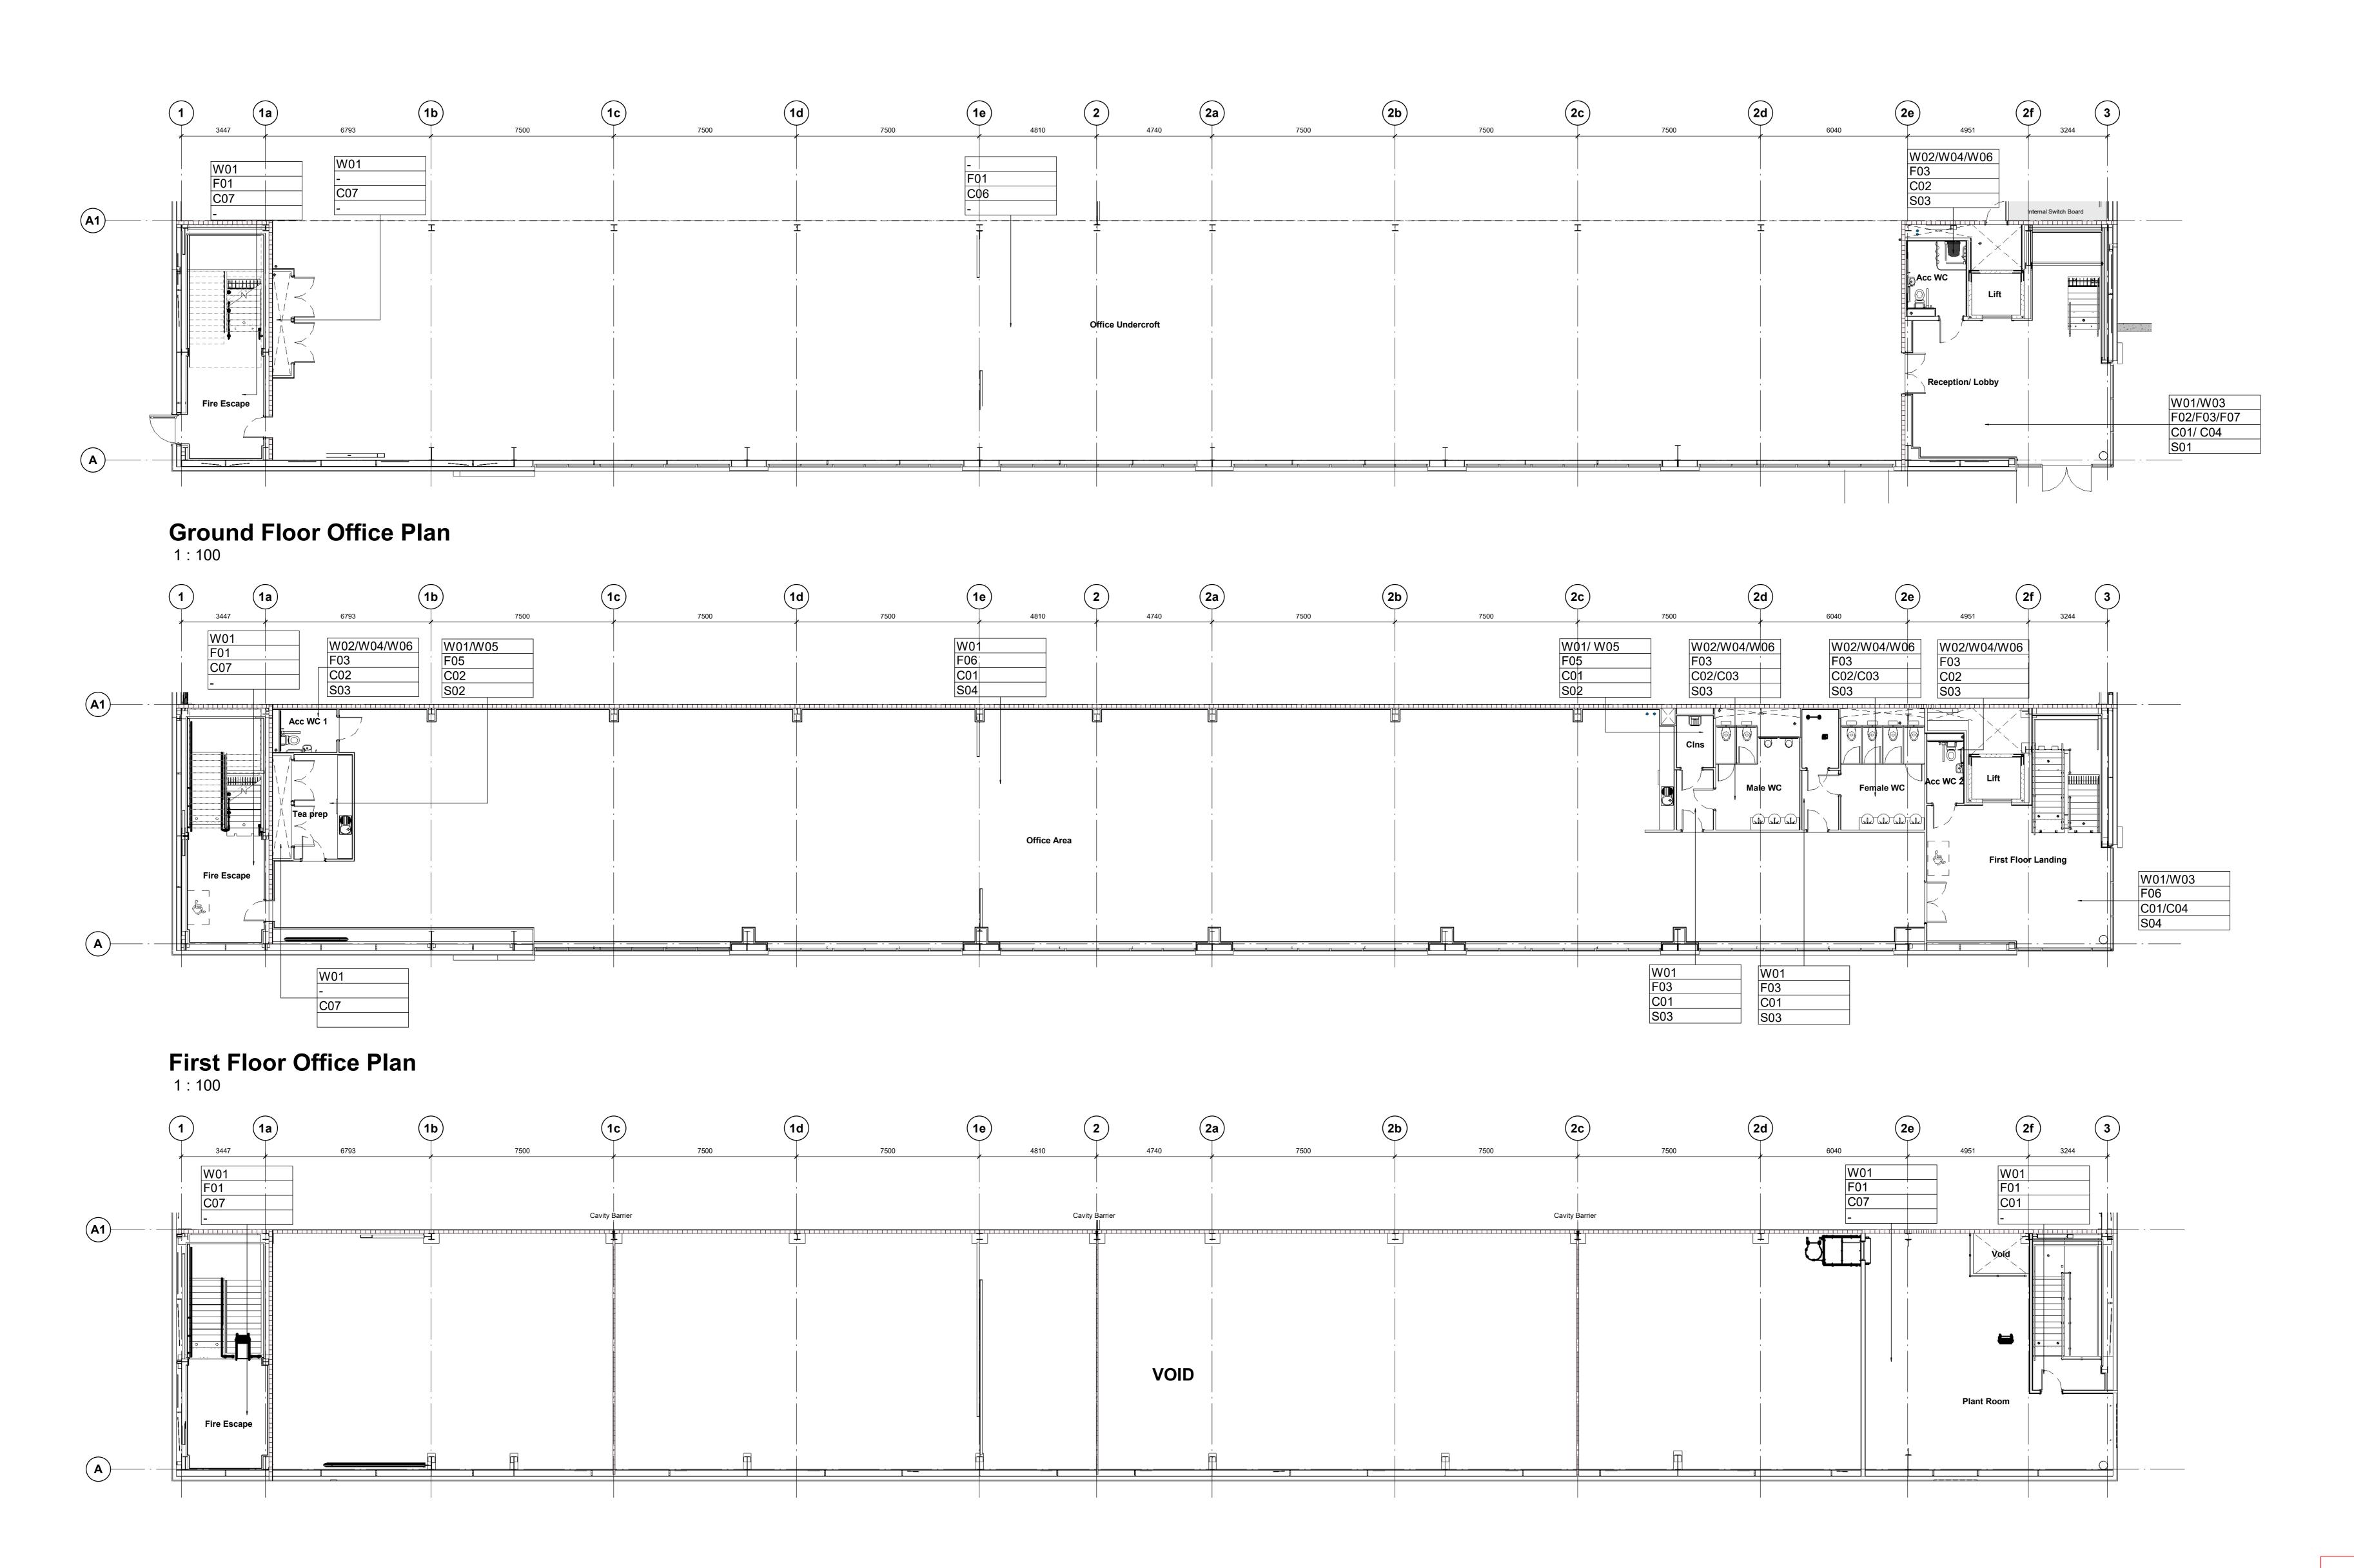

Plant Deck Plan
1: 100

Newark Beacon, o. +44 (0)1636 653027

RIBA POW Stage:
Document Suitability:
Drawn / Checked:
Date:
Scale:

Information Container LOIN

LOD 4

LOI 2

PANATTONI

Coccinitects

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RIBA PoW Stage: Stage 4 - Detailed Design

SW/LK 10/03/23

P23025_UMC _BR _ZZ _DR _A_ 1206

SCALE 1:100

SCALE 1:100

Document Reference:

Drawing no:







Power floated concrete or screed

600mmx600mmx11mm ceramic floor tiles Johnson Tiles Minerals Range MIN03G 'Limestone Grip'

600mmx600mm Johnson Tiles Minerals Range MIN05G Slate Skirting (S01) 600mmx50mmx9mm ceramic tiles

'Slate Natural'

Tiles Minerals Range MIN05N

600mmx600mm Johnson Tiles Minerals Range MIN05G Slate

Skirting (S03) 600mmx100mm Johnson Tiles Minerals Range MIN05N Slate Natural.


200mmx200mmx8.3mm ceramic floor tiles Johnson Tiles Kerastar KER558 'Clay Speckle' Natural; Skirting (S02) 200mmx100mmx8.3 Johnson Tiles Kerastar KER558 Clay Speckle

Interface Transformation 'Fern' 1628010 carpet tiles


Skirting (S04)
Ex 100mmx25mm hardwood to match the door veneer, splayed skirting for clear finishing. To be supplied by CFS, Stockdale range Colour: Chacoal - 3923

Fire retardent GRP grating


Installation of a transition strip betweem all changes in floor

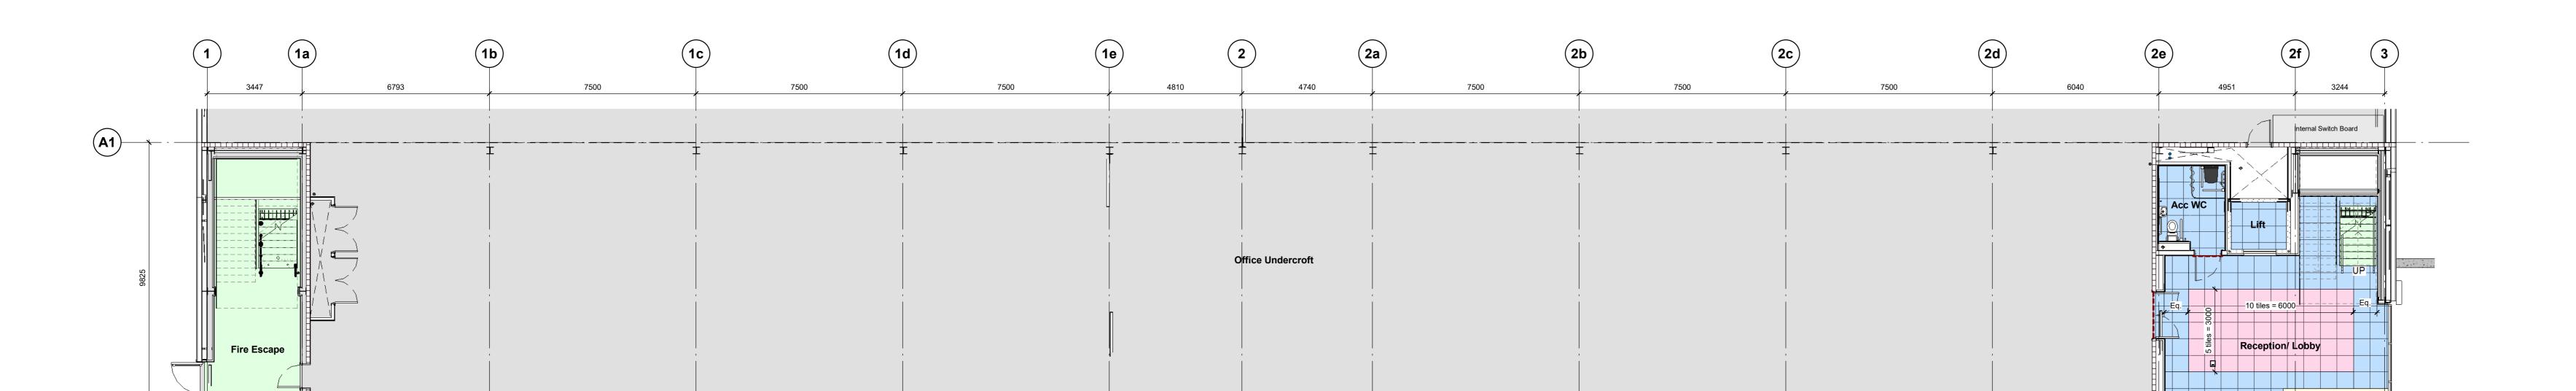

Ground Floor Office Plan

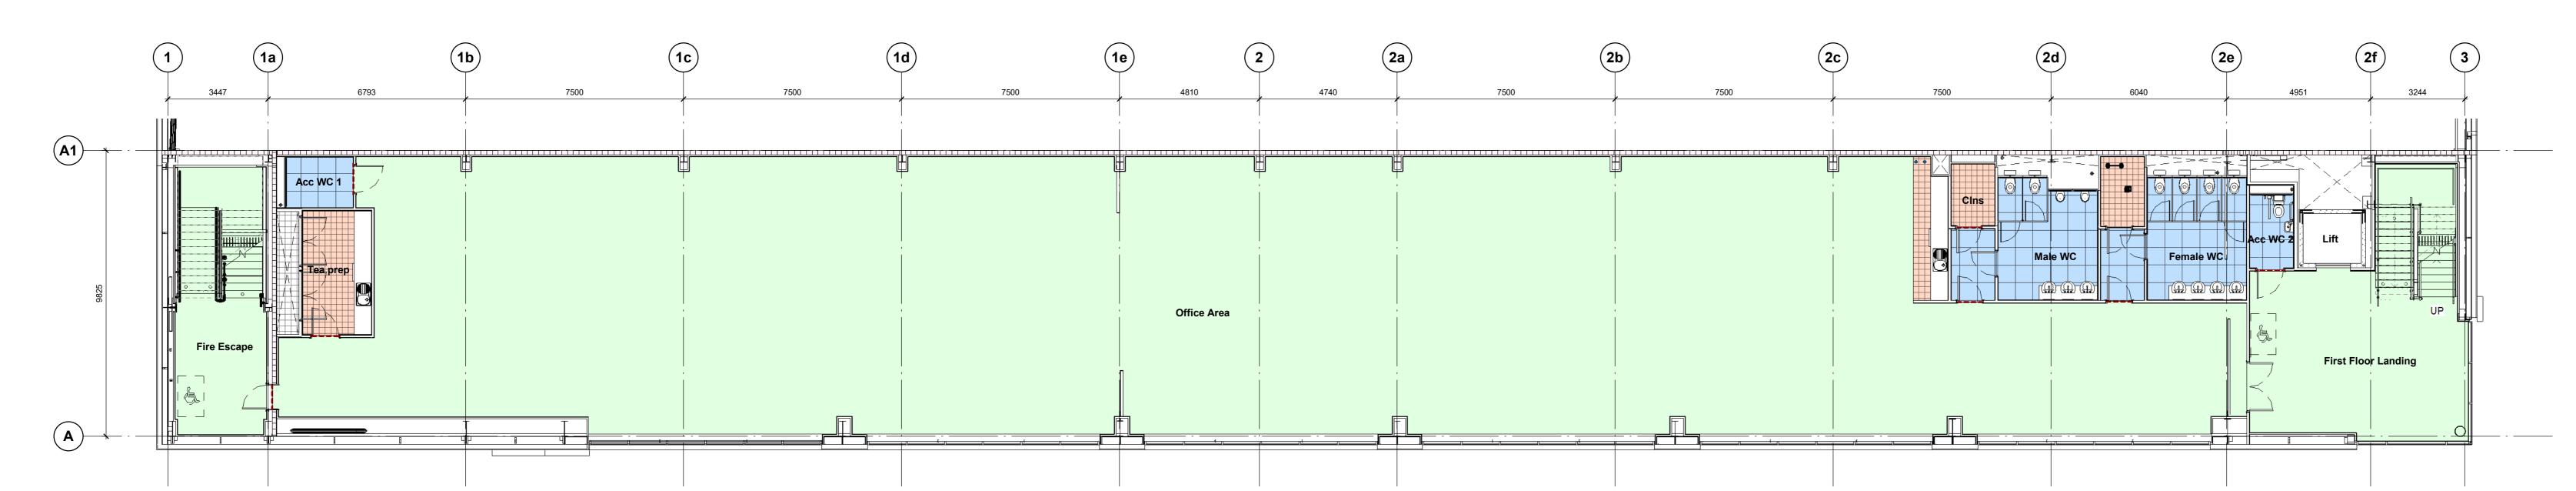


First Floor Office Plan

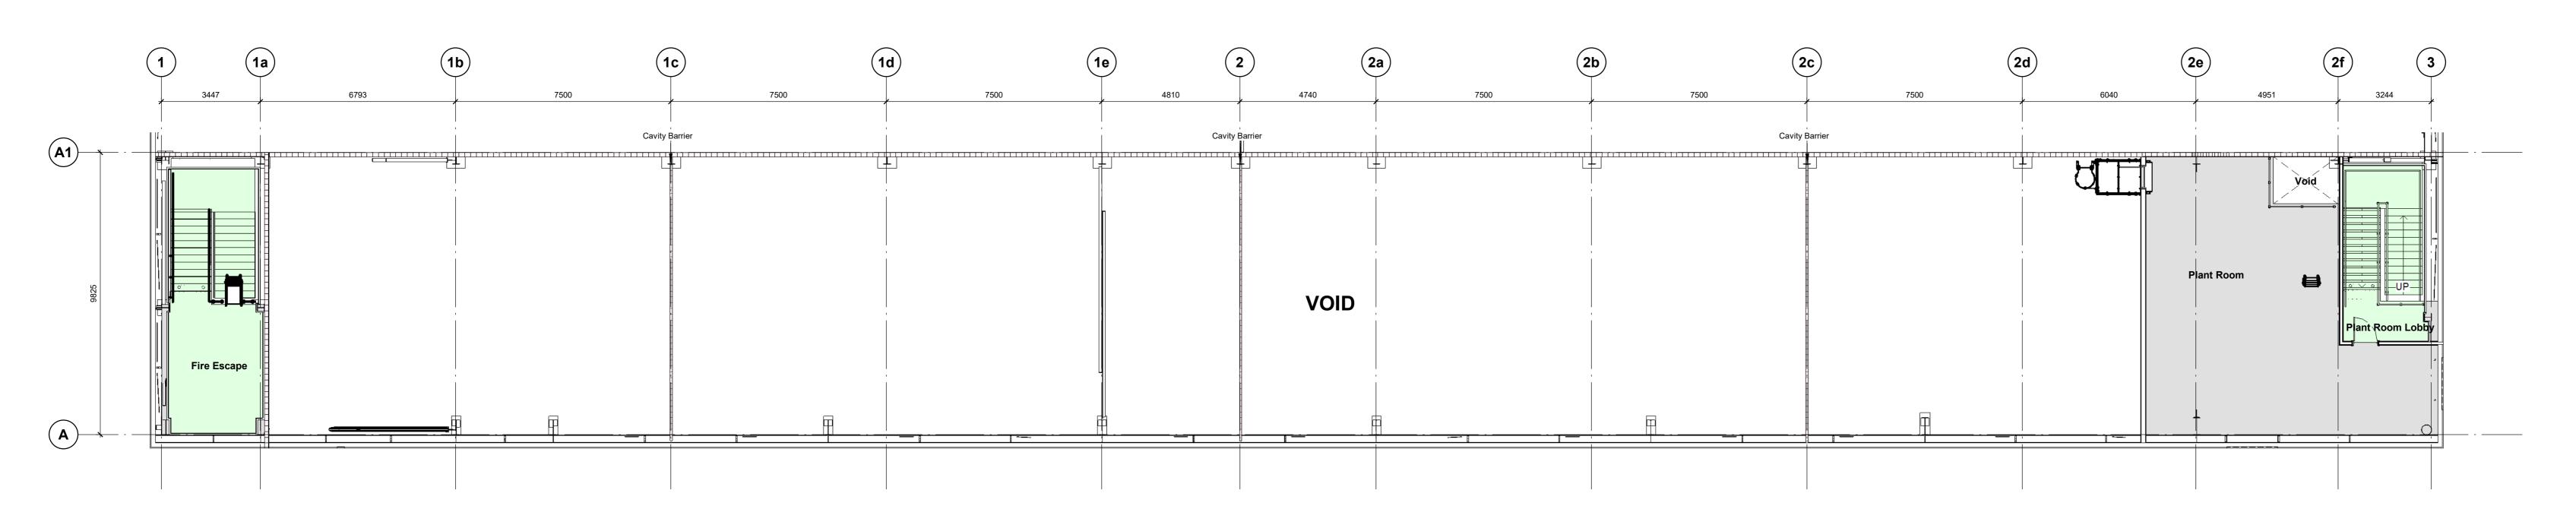

Plant Deck Plan

1:100

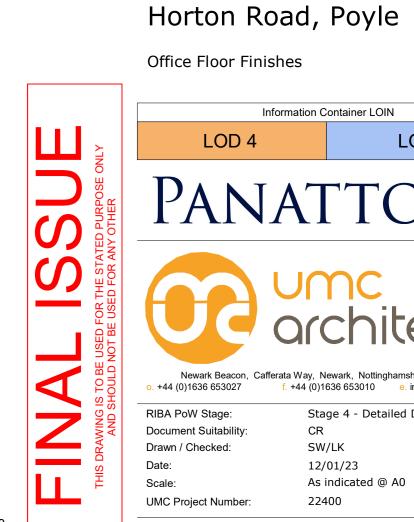

Information Container LOIN Stage 4 - Detailed Design

CR1 Construction Record Issue

included to cleaners store

P01 Issued for review and comment

C06 Drawing revised to include CAT ladder as LK SW 23.07.24 per Winvic email 22/07/24, carpet finishes updated to stairs and main office to be Fern as agreed with Panartoni, splash back included to cleaner stars.

C05 Staircase and landing finishes added to SW LK 26.06.24 drawing following confirmation in client meeting on 25.06.24

C04 Floor finish in the store amended to F05. SW LK 07.06.24 C03 Reception/ Lobby floor finish amened to SW LK 05.06.24

C02 Tiled flooring added to the open tea prep on SW LK 07.05.24 first floor. Tiled flooring in the reception area

C01 Drawing updated following acceptance of SW LK 05.03.24 layout reconfiguration. Office grids added to

align with ceiling tile setting out. Lift floor finish added to align with reception/ lobby.

LK SW 27.08.24


Document Suitability: Drawn / Checked: SW/LK 12/01/23 As indicated @ A0 22400 UMC Project Number:

Document Reference: P23025_UMC _BR _ZZ _DR _A_ 1208

VOID

Plant Deck Plan 1:100

- Dimensions are all in millimeters, unless stated otherwise.
- It is the recipients responsibility to print this document to the correct scale.
- All the relevant drawings and specifications should be read in conjunction with this drawing.
- Scaling of this drawing is not recommended.

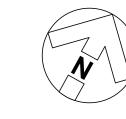

Key

WALL FINISHES



lining full height Plasterd/ dry lined and fully sealed. Painted with one mist coat and two coats Dulux Trade lining half height/ Diamond Matt emulsion paint BS4800 22B15 above and/ or 'Swansdown'.

> W02
> Main Wall Tiles: 600mmx300mm Johnson Tiles
> Minerals Range MIN02N Dolomite Natural, laid/fixed landscape format;

W03 600mmx300mm Johnson Tiles IMP05P Charcoal polished ceramic tiles laid/fixed landscape format. Mechanical safety/retaining fixing system (RAIFIX or equal and approved) to be employed for all feature wall tiling 3.0m or more AFFL. Feature tiled wall to be 'framed' between walls or between projecting 'nibs' constructed for this purpose. Feature tiled wall to be kept clear of any fixtures/fitting of any

<u>W04</u> Feature Wall Tiles: 600mmx100mm Johnson Tiles Minerals Range MIN05N Slate Natural, laid/fixed landscape format;

Splashback 200mmx100mmx6.5mm Johnsons Tiles "Prismatics" PRG1 White Gloss laid horizontally (landscape), with proprietary white gloss or brushed stainless steel trims to all Ceramic tiled splashback above all worktops taken up to underside of wall cupboards.

W06
Full height IPS to WCs, Urinals and vanity units.
Refer to sepcification for further details.

Construction Record Issue


Cos Drawing revised to include CAT ladder as per Winvic email 22/07/24, carpet finishes updated to stairs and main office to be Form as agreed with Panattoni, splash back included to cleaners store C02 Ground floor reception/ lobby arrangement SW LK 05.06.24 finishes update to reflect latest layout. Finishes amened to reflect mirroring of the

C01 Drawing updated following acceptance of SW LK 05.03.24 layout reconfiguration. Office grids added to P01 Issued for review and comment

Horton Road, Poyle

Office Wall Finishes

Document Suitability: Drawn / Checked:

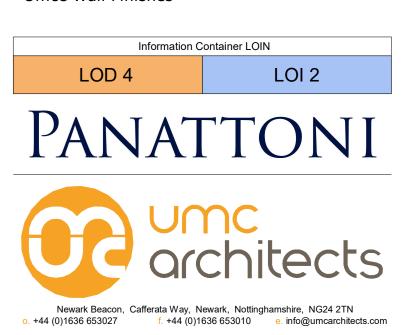

SW/LK 24/01/2024 As indicated @ A0

22400

Stage 4 - Detailed Design

UMC Project Number: Document Reference: P23025_UMC _BR _ZZ _DR _A_ 1209

